


Project Location Map
Not to Scale

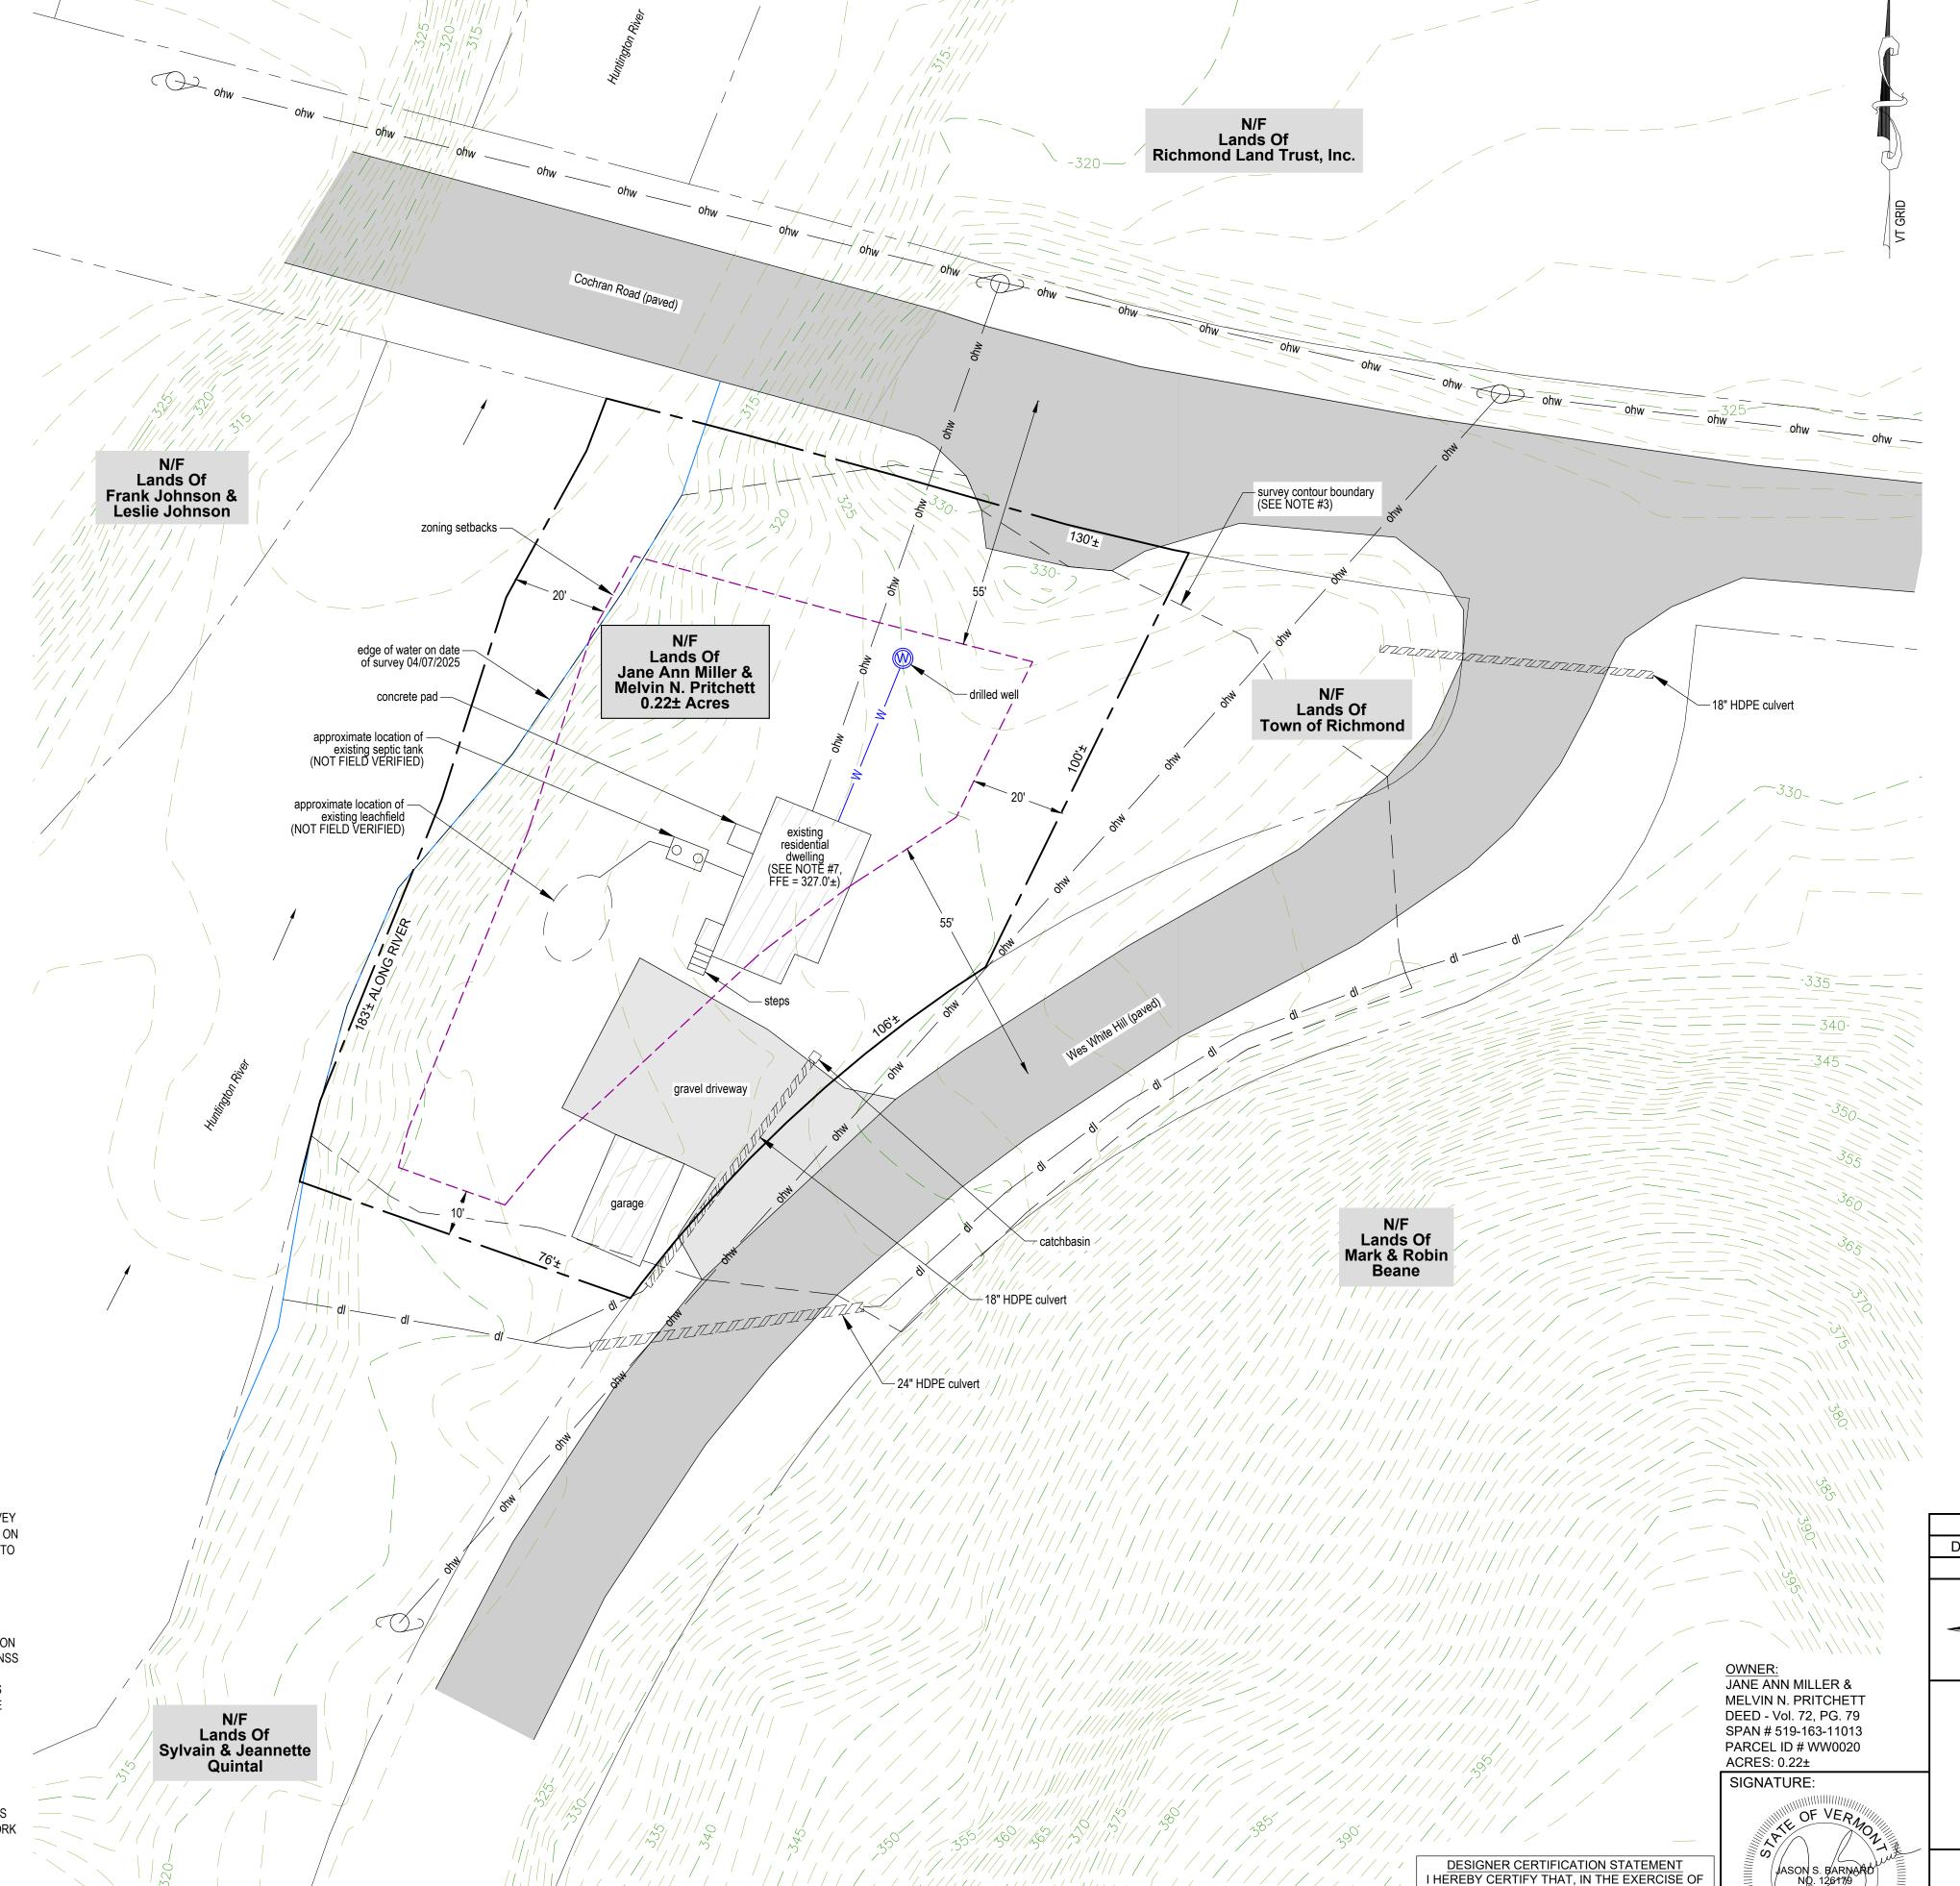

**ZONING INFORMATION** 

SETBACK - FRONT YARD: 55 FT. MIN. FROM ROAD CL

**LEGEND** 

---- 100 --- 1-FOOT GROUND SURVEY CONTOUR

UE UNDERGROUND ELECTRICAL CONDUIT

Ohw UTILITY POLE/ OVERHEAD WIRES

\_\_\_\_\_ ZONING SETBACKS

——— S ———— S ———— GRAVITY SEWER (EXISTING)

— dl — dl — DITCHLINE

BARNARD &

167 Main Street, P.O.Box 820 Enosburg Falls, VT 05450 Telephone: (802) 933-5168

MY REASONABLE PROFESSIONAL JUDGEMENT, THE DESIGN-RELATED INFORMATION

SUBMITTED WITH THIS APPLICATION IS TRUE

AND CORRECT AND THE DESIGN INCLUDED IN

THIS APPLICATION FOR A PERMIT COMPLIES

WITH THE VERMONT WASTEWATER SYSTEM

AND POTABLE WATER SUPPLY RULES.

JASON S. BARNARD

LICENSED DESIGNER #126179

GERVAIS, LLC

**EXISTING CONDITIONS PLAN** 

JANE ANN MILLER &

**MELVIN N. PRITCHETT** 

20 WES WHITE HILL, RICHMOND, VERMONT

SITE PLAN

THESE PLANS WITH LATEST REVISIONS SHOULD ONLY BE USED FOR

THE PURPOSE SHOWN BELOW:

PRELIMINARY DRAFT

BOUNDARY LINE/ R.O.W. (EXISTING)

——— 1-FOOT LIDAR CONTOUR

W — W — 1-INCH DIAMETER CL200 POLYETHYLENE PLASTIC

DESCRIPTION

REVISIONS

BOUNDARY LINE/ R.O.W. (ABUTTING)

(OBTAINED FROM VCGI DATABASE)

WATER LINE (UNLESS OTHERWISE NOTED)

Land Surveying
Water & Wastewater

10523 VT Route 116, P.O.Box 133 Hinesburg, VT 05461 Telephone: (802) 482-2597 PROJECT NO. 25233

Environmental Consulting

DATE:

04-08-2025

SCALE:

1" = 20'

SURVEY:

DRAWN:

CHECKED:

DRAWING NO.

SHEET 1 OF 1

JG, DT

BY

DRILLED WELL (UNLESS OTHERWISE NOTED)

FINAL LOCAL REVIEW

20 FT. MIN. (PRIMARY) 10 FT. MIN. (ACCESSORY)

20 FT. MIN.

30% MAX.

35 FT. MAX.

AGRICULTURAL/RESIDENTIAL DISTRICT (AR)

ZONING DISTRICT

ROAD FRONTAGE:

LOT COVERAGE:

BUILDING HEIGHT:

SETBACK - SIDE YARD:

SETBACK - REAR YARD:

DIMENSIONAL REQUIREMENTS

## ROJECT NOTES:

1. THIS IS NOT A BOUNDARY SURVEY AND DOES NOT MEET THE LEGAL REQUIREMENTS OF A BOUNDARY SURVEY AS DESCRIBED IN 27 V.S.A. § 1403. PROJECT PERIMETER LINES ARE BASED ON RICHMOND TAX MAPS SHOWN ON THE AGENCY OF NATURAL RESOURCES (ANR) ENVIRONMENTAL INTEREST LOCATOR. NO WARRANTY IS MADE TO THE ACCURACY OF THE BOUNDARY LINES SHOWN HEREON.

2. THE LOCATIONS OF EXISTING PHYSICAL FEATURES ON THIS PLAN ARE BASED ON A TOPOGRAPHIC SURVEY COMPLETED BY BARNARD AND GERVAIS, LLC IN APRIL 2025.

3. THE ELEVATIONS ON THIS PLAN WITHIN THE DASHED BOUNDARIES SHOWN ARE 1-FOOT CONTOURS BASED ON NAVD88 (GEOID18) ESTABLISHED FROM SURVEY GRADE GNSS READINGS COLLECTED WITH A TRIMBLE R12i GNSS RECEIVER ADJUSTED TO VERMONT GRID ON RANDOM CONTROL POINTS USING REAL TIME KINEMATIC CORRECTIONS FROM A VIRTUAL REFERENCE STATION OF THE VT CORS NETWORK. THE ELEVATIONS ON THIS PLAN OUTSIDE THE DASHED BOUNDARIES SHOWN ARE 1-FOOT LIDAR CONTOURS OBTAINED FROM THE STATE OF VERMONT VCGI OPEN DATA PORTAL DATABASE.

4. FOR CLARITY, TEXT IDENTIFYING EXISTING ITEMS IS LOWER CASE; TEXT IDENTIFYING PROPOSED ITEMS IS UPPER CASE.

5. NO ATTEMPT HAS BEEN MADE TO LOCATE ANY UNDERGROUND UTILITIES BY BARNARD AND GERVAIS, LLC. THE CONTRACTOR WILL BE RESPONSIBLE FOR <u>CONTACTING DIG SAFE</u> TO HAVE ANY UNDERGROUND UTILITIES MARKED PRIOR TO ANY EXCAVATION OR SITE WORK. THE CONTRACTOR SHALL NOTIFY THE DIG SAFE NETWORK AT LEAST 72 HOURS PRIOR TO THE START OF CONSTRUCTION.

6. BARNARD & GERVAIS, LLC IS NOT RESPONSIBLE FOR ANY ASPECTS OF HEALTH AND SAFETY ASSOCIATED WITH THIS PROJECT.

7. THE EXISTING RESIDENTIAL DWELLING WAS DAMAGED DURING THE JULY 2024 FLOODING. THE BASE FLOOD ELEVATION WAS ESTABLISHED AT 324 FEET AND AS PART OF THE REBUILDING PROCESS, THE NEW FINISH FLOOR ELEVATION WAS SET AT 327 FEET. THE EXISTING RESIDENTIAL DWELLING WAS RECONSTRUCTED ON THE SAME FOOTPRINT.